DEVELOPMENT APPLICATION PROPOSED ALTERATIONS & ADDITIONS & GARAGE RENOVATION 2 LAKEMBA STREET, BELMORE 2192 - LOT D / DP 416117 FOR MR EMANUEL KARAGEORGIOU

DRAWING SCHEDULE

COVERS	HEET, SPECIFICATION & SITE PLANS		
A001	COVER SHEET, DRAWING SCHEDULE & LOCATION PLAN	С	29/04/25
A002	SITE ANALYSIS PLAN & COMPLIANCE TABLE	С	29/04/25
A003	SITE PLAN	С	29/04/25
A004	LANDSCAPE PLAN	С	29/04/25
ESCP	EROSION/SEDIMENT CONTROL PLAN	С	29/04/25
SWP	CONCEPT STORMWATER PLAN	С	29/04/25
PLANS			
A101	FLOOR PLAN (EXISTING & DEMOLITION)	С	29/04/25
A102	FLOOR PLAN (PROPOSED)	С	29/04/25
ELEVATI	ONS		
A201	DWELLING ELEVATIONS	С	29/04/25
A202	OUTBUILDING ELEVATIONS	С	29/04/25
SECTION	IS		
A301	SECTIONS	С	29/04/25
SCHEDU	LES		
A401	SCHEDULE OF COLOUR & FINISHES	С	29/04/25
A402	BASIX COMMITMENTS	С	29/04/25
NEIGHB	OUR NOTIFICATIONS		
NN01	NEIGHBOUR NOTIFICATIONS	С	29/04/25
· · · · ·			



3D PERSPECTIVE (EXISTING ELEMENTS SHOWN WHITE)



LOCATION PLAN

COUNCIL

CITY OF CANTERBURY BANKSTOWN

PROJECT DESCRIPTION

PROPOSED ALTERATIONS & ADDITIONS & GARAGE RENOVATION





This drawing is copyright and is the property of Next Level Design Studio and it can not be reproduced in whole or part without prior written permission <u>NOT</u> scale off drawings and rep crepancies to the designer befor


ing work orks and materials are to evant codes, specifications & loca

2 LAKEMBA STREET, BELMORE 2192

(LIENT	
ľ	MR EMANUEL	KARAGEORGIOU

SITE ADDRESS 2 LAKEMBA STREET, BELMORE 2192 LOT D / DP 416117


SCALE A3 DRAWN PA 29/04/25 DATE 1329 JOB No. REV No. C. <u>DWG No.</u> **A001**

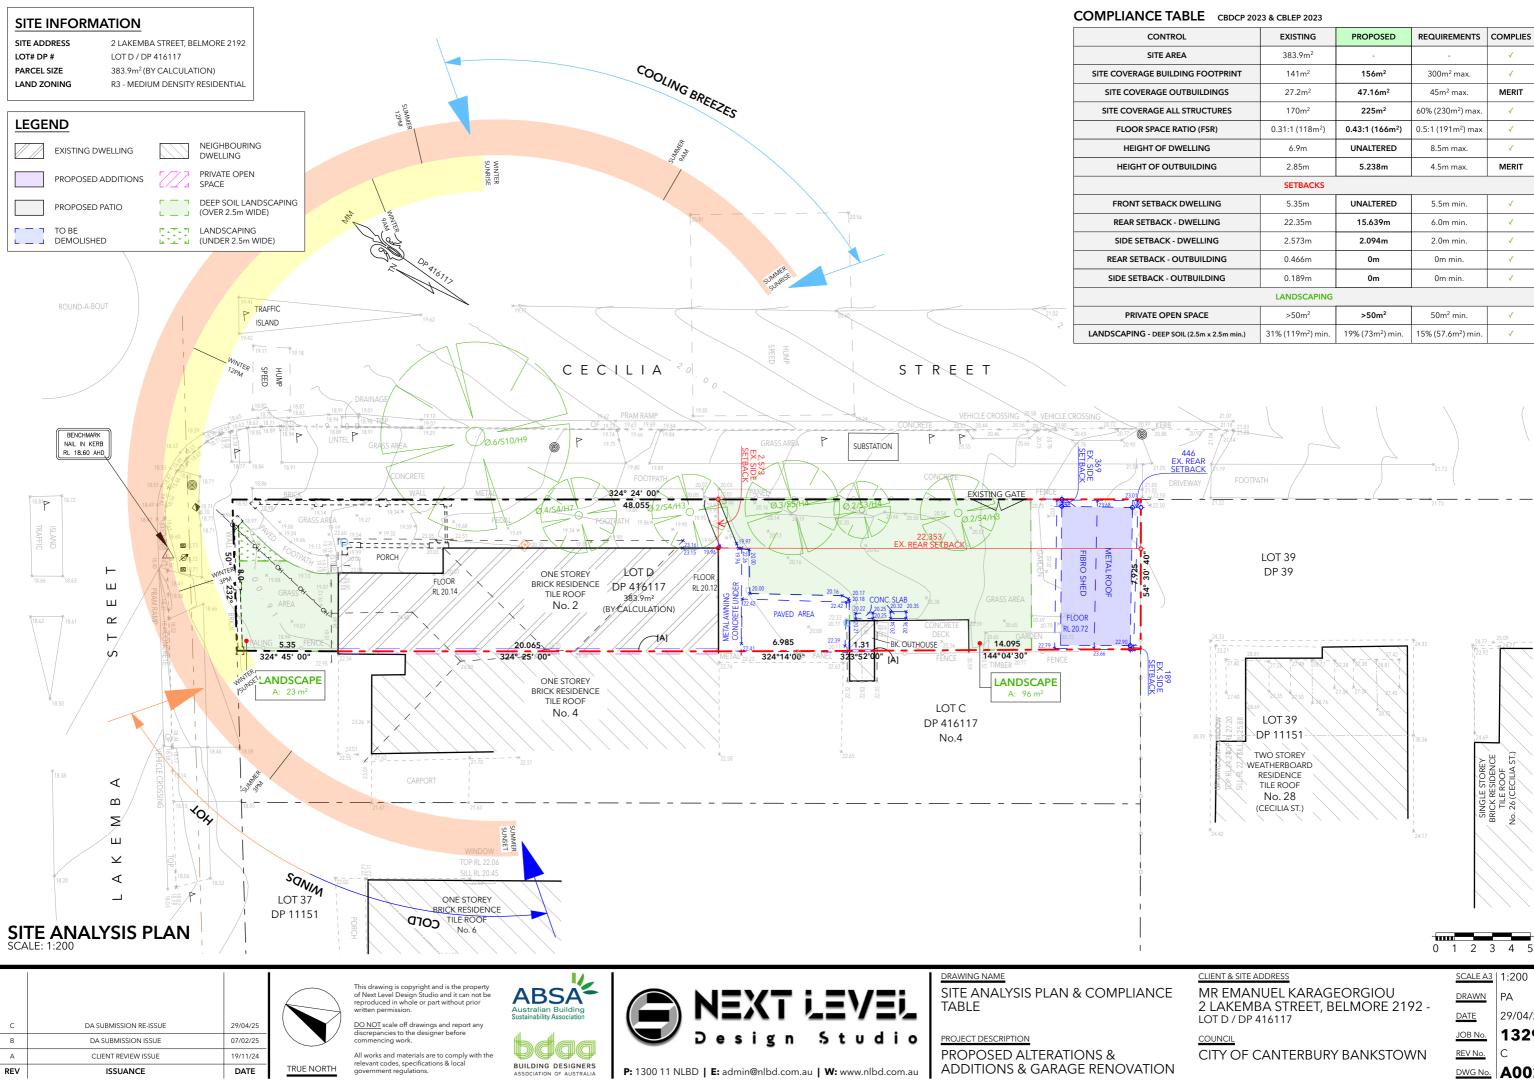

ABLE	CBDCP 2023 & CBLEP 2023
------	-------------------------

RDEE CBDCF 202	13 & CDLLF 2023				
ROL	EXISTING	PROPOSED	REQUIREMENTS	COMPLIES	
REA	383.9m ²	-	-	1	
DING FOOTPRINT	141m ²	156m ²	300m² max.	1	
DUTBUILDINGS	27.2m ²	47.16m ²	45m² max.	MERIT	
LL STRUCTURES	170m ²	225m ²	60% (230m²) max.	1	
RATIO (FSR)	0.31:1 (118m ²)	0.43:1 (166m ²)	0.5:1 (191m ²) max	√	
WELLING	6.9m	UNALTERED	8.5m max.	√	
ITBUILDING	2.85m	5.238m	4.5m max.	MERIT	
	SETBACKS				
K DWELLING	5.35m	UNALTERED	5.5m min.	✓	
- DWELLING	22.35m	15.639m	6.0m min.	√	
- DWELLING	2.573m	2.094m	2.0m min.	✓	
OUTBUILDING	0.466m	0m	0m min.	✓	
OUTBUILDING	0.189m	0m 0m min.		✓	
	LANDSCAPING			·	
EN SPACE	>50m ²	>50m ²	50m ² min.	✓	
SOIL (2.5m x 2.5m min.)	31% (119m ²) min.	19% (73m²) min.	15% (57.6m ²) min.	✓	

	0	1	2	3	4	5
CLIENT & SITE ADDRESS		SC	ALE	A3	1:20	00
MR EMANUEL KARAGEORGIOU 2 LAKEMBA STREET, BELMORE 2192 -		DF	RAWN	V	PA	
LOT D / DP 416117		DA	ΑTE		29/0)4/25
COUNCIL		JC)B No). -	13	29
CITY OF CANTERBURY BANKSTOWN		RE	V No		С	
		D١	NG N	lo.	A0	02

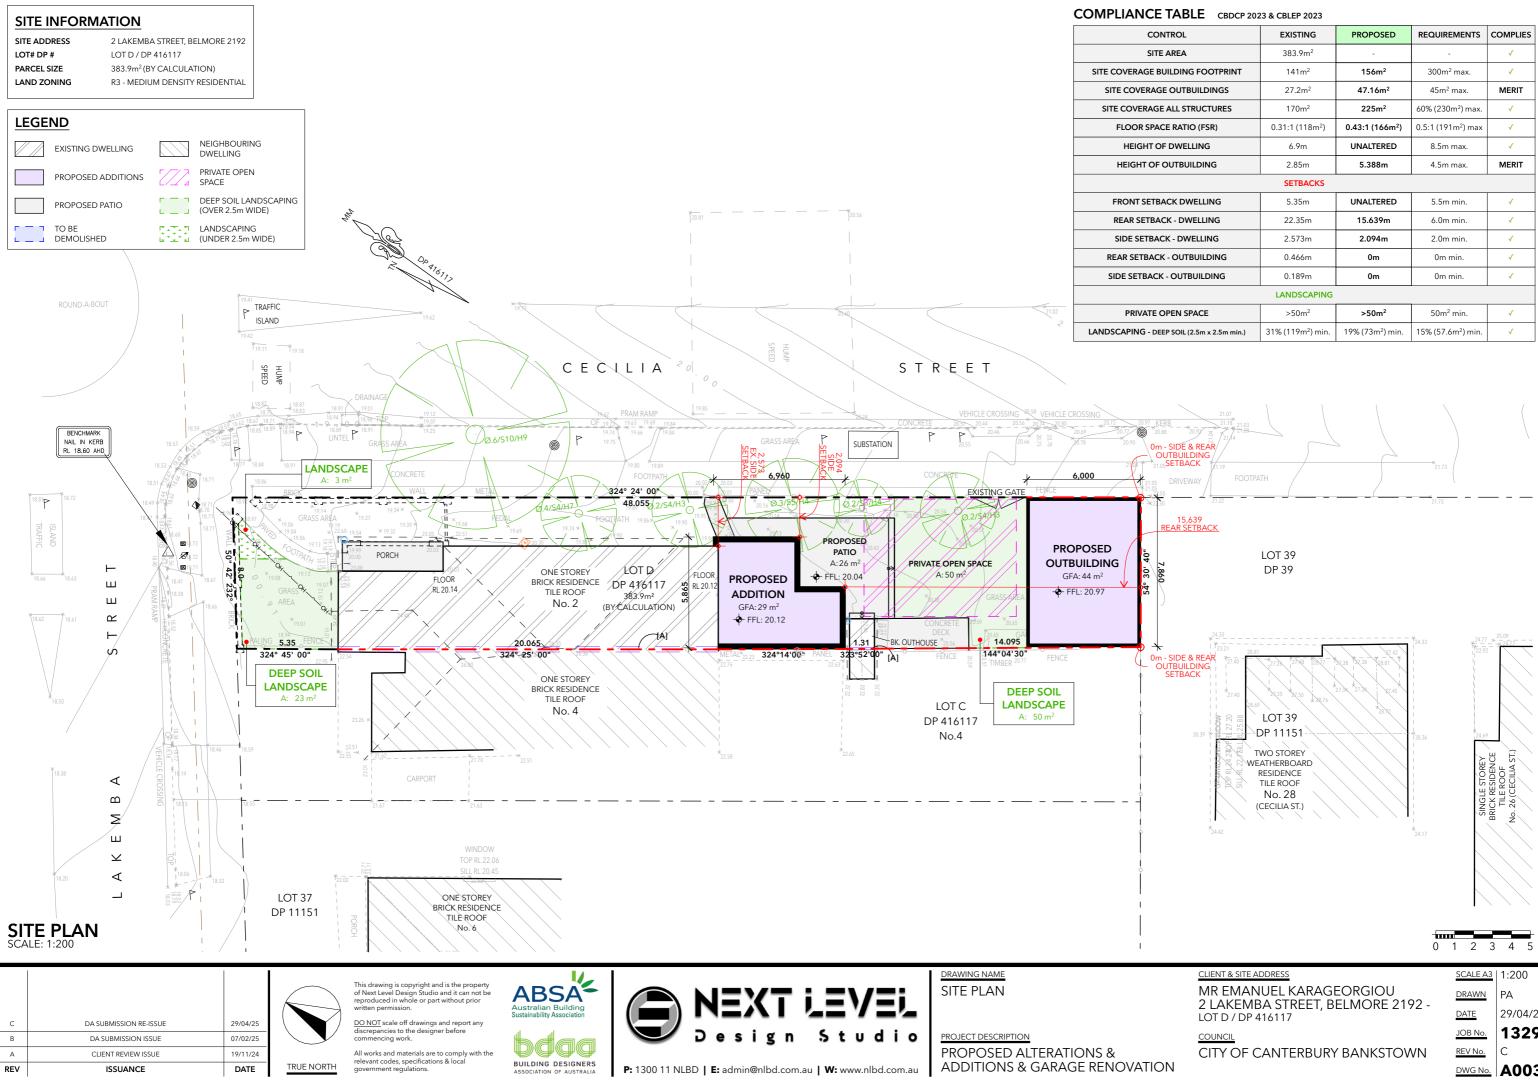

ADEL CBDCF 202	13 & CBLEF 2023				
ROL	EXISTING	PROPOSED	REQUIREMENTS	COMPLIES	
REA	383.9m ²	-	-	√	
DING FOOTPRINT	141m ²	156m ²	300m² max.	√	
DUTBUILDINGS	27.2m ²	47.16m ²	45m² max.	MERIT	
LL STRUCTURES	170m ²	225m ²	60% (230m²) max.	√	
RATIO (FSR)	0.31:1 (118m ²)	0.43:1 (166m ²)	0.5:1 (191m ²) max	√	
WELLING	6.9m	UNALTERED	8.5m max.	√	
ITBUILDING	2.85m	5.388m	4.5m max.	MERIT	
	SETBACKS				
K DWELLING	5.35m	UNALTERED	5.5m min.	<	
- DWELLING	22.35m	15.639m	6.0m min.	<	
- DWELLING	2.573m	2.094m	2.0m min.	<	
OUTBUILDING	0.466m	0m	0m min.	<	
OUTBUILDING	0.189m	Om Om min.		<	
	LANDSCAPING				
EN SPACE	>50m ²	>50m ²	50m ² min.	<	
SOIL (2.5m x 2.5m min.)	31% (119m ²) min.	19% (73m²) min.	15% (57.6m ²) min.	✓	

	0	1	2	3	4	5
CLIENT & SITE ADDRESS		SC	CALE	A3	1:20	00
MR EMANUEL KARAGEORGIOU 2 LAKEMBA STREET, BELMORE 2192 -		Dł	NAS	V	PA	
LOT D / DP 416117		DA	ΑTE		29/()4/25
COUNCIL		JC)B No	o.	13	29
CITY OF CANTERBURY BANKSTOWN		RE	VNo		С	
		D١	NG N	lo.	AO	03

SPECIFICATIONS

1. PLANTING MATERIALS

PLANTING MIX:

Planting mix for tree pit backfill shall be "Organic Garden Mix" consisting of - 50% Black Soil

- 20% Coarse Sand
- 30% Organic Material

Samples shall be provided to the Superintendent prior to ordering or delivery to site. Any material delivered to site, that is rejected by the Superintendent, shall be removed by the contractor at his own expense. Minimum depths of mix to all planting bed areas is as specified on details.

PLANTER MIX: Planter mix shall be Peat and Planter Mix.

PLANTER DRAINAGE CELL:

Planter drainage cell shall be VersiCell where applicable

MULCH

Mulch to garden bed: Mulch shall mean hardwood mulch (25mm grade), free from material derived from Privet, Willow, Poplar, Coral trees, or other noxious weeds. Any mulch exceeding the 25mm grade shall be rejected / removed from the site. Mulch to planter beds Mulch to planter beds shall be Pine bark mini nuggets mulch (25mm grade), free from fines.

Spread mulch so that after settling, it is:

smooth and evenly graded between design surface levels;

flush with adjacent finished levels;

- of the required depths (75mm); and

- sloped towards the base of plant stems in plantation beds, but not in contact with the stem (not closer than 50mm in the case of gravel mulches).

Place after the preparation of the planting bed, planting and all other work

PLANT MATERIAL:

All plant material must be true to the species. No substitutes will be allowed. All plants shall be free of fungus and insect damage. All plants shall be healthy, well shaped, not soft or force grown and not root bound.

TURFED AREAS:

All new turfed areas are to be selected weed free. Turf shall be laid neatly butted with staggered joins, flush with adjacent surfaces and have even running falls to all drainage points. All new turfed area shall have a minimum 150mm depth of weed free top soil,

placed and levelled prior to turfing.

2. PREPARATION AND HARDWORKS EXCAVATING FOR SPOT PLANTING:

To planting areas, excavate a hole for each plant large enough to provide not less than twice the depth and twice the diameter than the root ball of species to be planted.

STAKING:

Use durable hardwood, straight, free from knots or twists, pointed at one end. Drive stakes into the ground a minimum one third of their length, avoiding damage to the root system

- 45 Litre trees in 2 x 38 x 38x I 800mm Hardwood Stake with double Nylon tie TIES: Provide a 50mm wide Nylon webbing tie per stake, fixed securely to the stakes, one tie at half the height of the main stem and the other as necessary to stabilise the plant

TIMBER EDGE

MATERIAL: Timber edging shall consist of:

Edging: 100 x 50mm hardwood

В

А

REV

Pegs: 50 x 50 x 400mm hardwood.

Fastenings: to be 75 x 3.75mm diam. galvanised nails

INSTALLATION: Setout alignment of timber edges on site for approval of Superintendent. Excavate to approved alignment and place edge band within trench to confirm peg locations. Install pegs and affix timber edge in accordance with details. All timber edging to finish flush with adjoining turf.

3. MAINTENANCE/ PLANT ESTABLISHMENT


DA SUBMISSION ISSUE

CLIENT REVIEW ISSUE


ISSUANCE

Maintenance shall apply to all hard and soft landscape materials installed prior to the "handover" and acceptance by Principles Representative and the Site Superintendent. The maintenance period shall convenience at the granting of practical completion and shall extend for 26 weeks. Maintenance shall consist of the following works:

- Follow a daily watering programme to be approved by Superintendent. Water all plants individually, twice per week or when necessary to ensure constant plant growth. Water all turf and native grassed areas, twice per week.

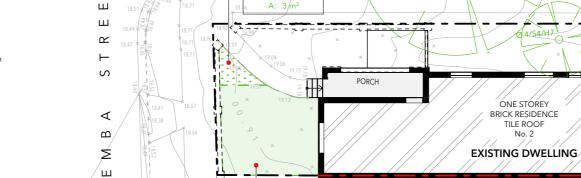

LANDSCAPE

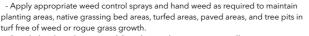

responsibility of the Contractor. Replacement planting will be undertaken within 2


Report any incidence of plants stolen or destroyed by vandalism

- Adjust stakes and ties to plants as necessary. Ensure that strangulation of plants does not occur.

- Make good any defects or faults arising out of defective workmanship or

- Make good any erosion or soil subsidence, which may occur including soft areas

- A final inspection shall be made by the Superintendent before handover. Any

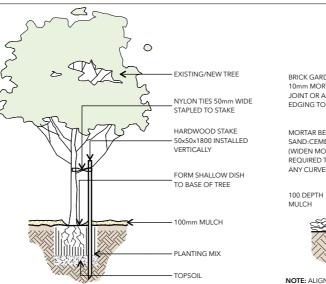



LANDSCAPE PLAN

PROJECT DESCRIPTION **PROPOSED ALTERATIONS &** ADDITIONS & GARAGE RENOVATION

CONTR SITE AR PRIVATE OPEI

LANDSCAPING - DEEP SC

STREET

PROPOSED

ADDITION

GFA: 29 m²

+ FFL: 20.12

LANDSCAPE A: 23 m² LANDSCAPE PLAN

DEEP SOIL

SCALE: 1:200

turf free of weed or rogue grass growth. - Regularly tidy and top up mulch and trim edges to prevent spill over onto paved / grassed areas.

Spray to control pests and diseases.

 \leq

∢

_

- Replace plants, which fail with plants of a similar size and quality as originally specified to approval of Superintendent. Costs of replacement shall be the weeks of identification of dead material or instruction be the Superintendent.

- Prune and shape plants as directed or where necessary.

materials - Fertilise lawn areas to maintain healthy growth

in pathways.

- Mow lawn to maintain neat healthy growth

items requiring rectification shall be repaired before the works are finally approved, and retention moneys released.



TRUE NORTH

DO NOT scale off drawings and repo discrepancies to the designer before icing work. All works and materials are to comply with the relevant codes, specifications & local


BUILDING DESIGNERS P: 1300 11 NLBD | E: admin@nlbd.com.au | W: www.nlbd.com.au

DRAWING NAME

100 DEPTH. SHAPE SUB-SOIL

300 TOPSOIL & ERTILISER MIX

NOTE: ALIGNMENT OF BRICK EDGE SHALL BE EVEN & FREE FROM DIPS AND HUMPS TURF & GARDEN EDGE DETAIL NTS

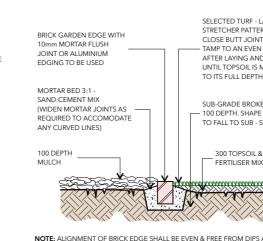

CECILIA

a 6/510/H9

√ÓT D∕

DP 416117

383/9m²

(BY CALCULATION)

TREE STAKING DETAIL NTS

Ø.2/

ROPOSED


PATIO

A:26 m²

+ FFL: 20.04

COMPLIANCE TABLE CBDCP 2023 & CBLEP 2023

ROL	EXISTING	PROPOSED	REQUIREMENTS	COMPLIES
REA	383.9m ²	-	-	<
EN SPACE	>50m ²	>50m ²	50m ² min.	<
SOIL (2.5m x 2.5m min.)	31% (119m²) min.	19% (73m²) min.	15% (57.6m²) min.	<

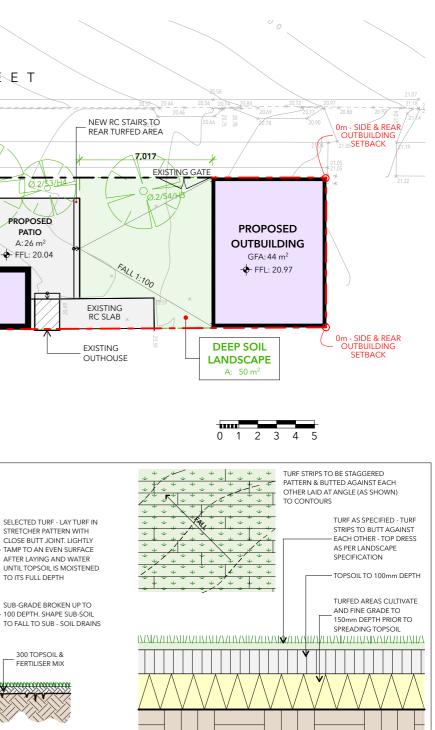


CLIENT & SITE ADDRESS MR EMANUEL KARAGEORGIOU 2 LAKEMBA STREET, BELMORE 2192 -LOT D / DP 416117

TURFING DETAIL NTS

COUNCI CITY OF CANTERBURY BANKSTOWN

1:200
PA
29/04/25
1329
С
A004

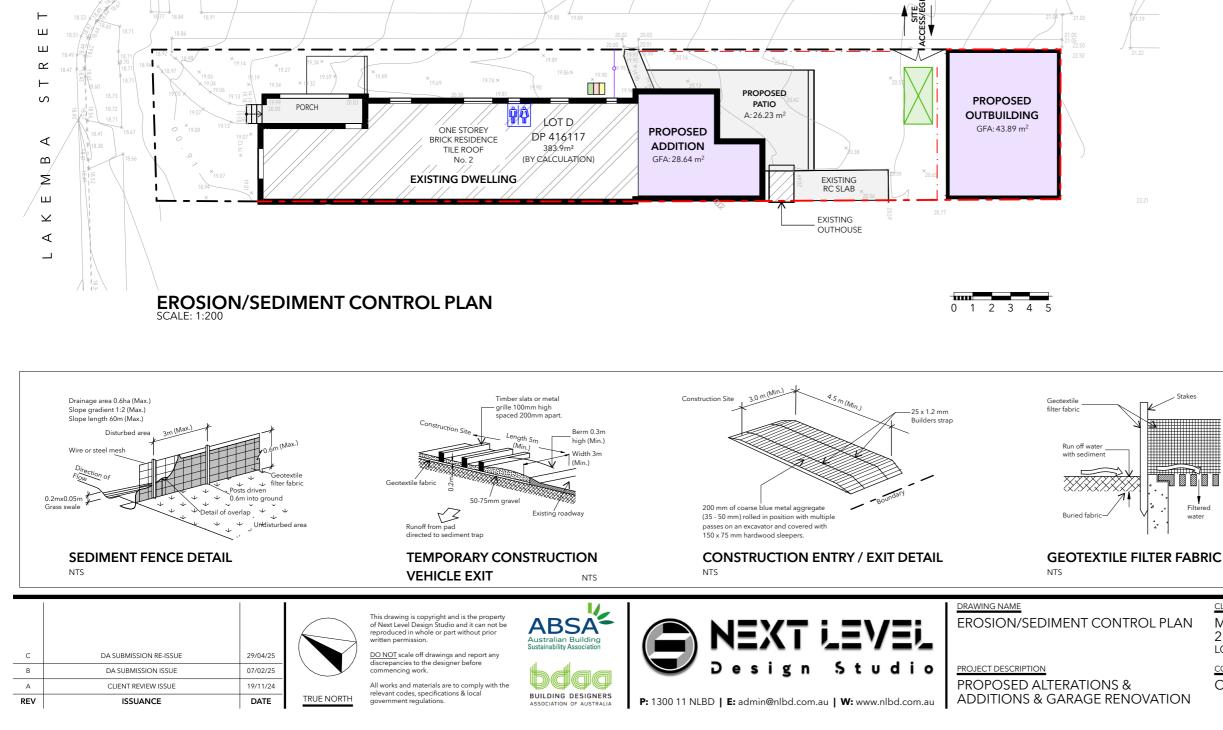

STREET


EXISTING KERB/ LAYBACK


V 20.46S

CECILIA

NOTES


- 1. NO VEHICLE CROSSING OR STOCKPILING OF MATERIAL SHOULD OCCUR ON THE VEGETATED BUFFER.
- 2. ALL SEDIMENT CONTROL STRUCTURES SHOULD BE INSPECTED & MAINTAINED BY THE SITE MANAGER DAILY.
- ALL RESTING STRUCTURES SHOULD BE CLEANED ON REACHING 50% OF STORAGE CAPACITY. SEDIMENT REMOVED SHOULD BE SPREAD WITHIN THE DISTURBED AREA.
- ALL EXISTING VEGETATION ON THE SITE PERIMETER MUST BE RETAINED.
 ROOF GUTTERS AND DOWNPIPES MUST BE CONNECTED TO THE SITE DRAINAGE IMMEDIATELY AFTER ROOF CONSTRUCTION.
- 6. ALL DISTURBED AREAS ARE TO BE REVEGETATED OR STABALISED TO PREVENT EROSION I.E. LANDSCAPING/MULCHING TURFING.
- 7. MATERIALS ARE NOT TO BE STORED ON THE FOOTPATH.

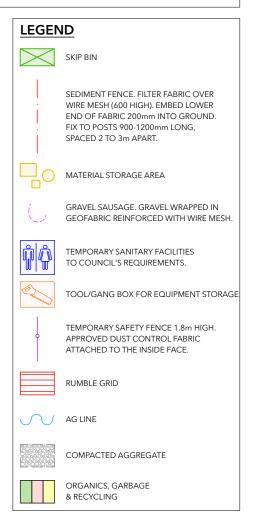

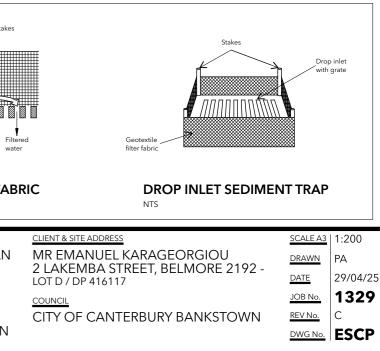



• IF A NEW STORMWATER LINE IS CONNECTED TO AN EXISTING STORMWATER LINE A PLUMBER IS TO CHECK & CONFIRM ADEQUACY OF EXISTING LINE TO SUPPORT ADDITIONAL STORMWATER.

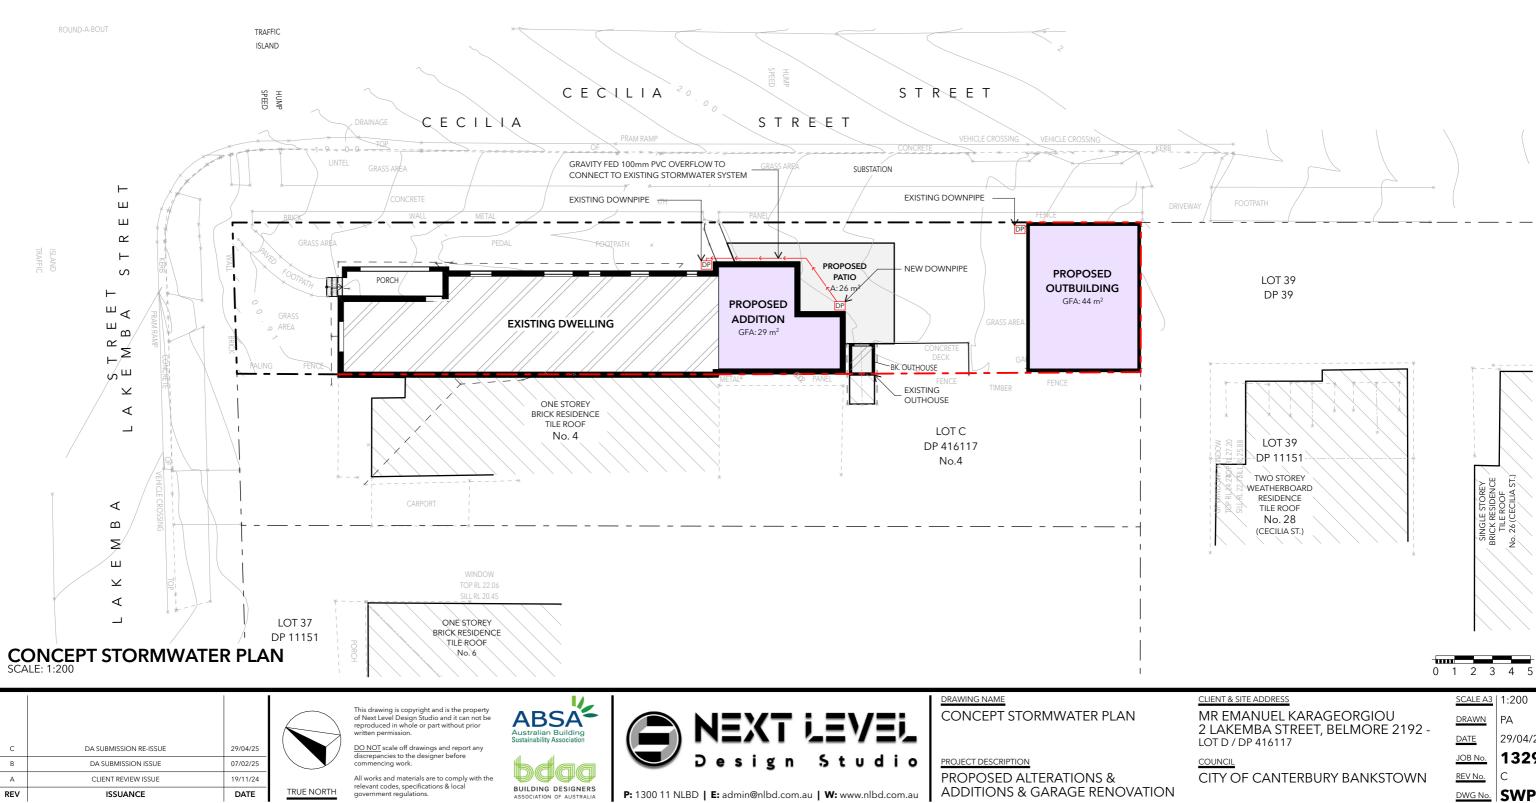


С


PLANS TO BE INSPECTED AND CERTIFIED BY A QUALIFIED ENGINEER.

• STORMWATER DESIGN PLAN IS CONCEPT ONLY AND MUST COMPLY WITH AS 3500.3:2015 PLUMBING & DRAINAGE - STORMWATER DRAINAGE & RELEVANT DCP.


LOT	39
DP	39

	0	1	2	3	4	5	
CLIENT & SITE ADDRESS		SC	ALE /	A3	1:20	0	
MR EMANUEL KARAGEORGIOU		DF	RAWN	J	PA		
2 LAKEMBA STREET, BELMORE 2192 - LOT D / DP 416117		DA	ATE		29/0)4/25	
COUNCIL		JC)B No	<u>).</u>	13	29	
CITY OF CANTERBURY BANKSTOWN		RE	V No	-	С		
		D١	NG N	lo.	SW	/P	

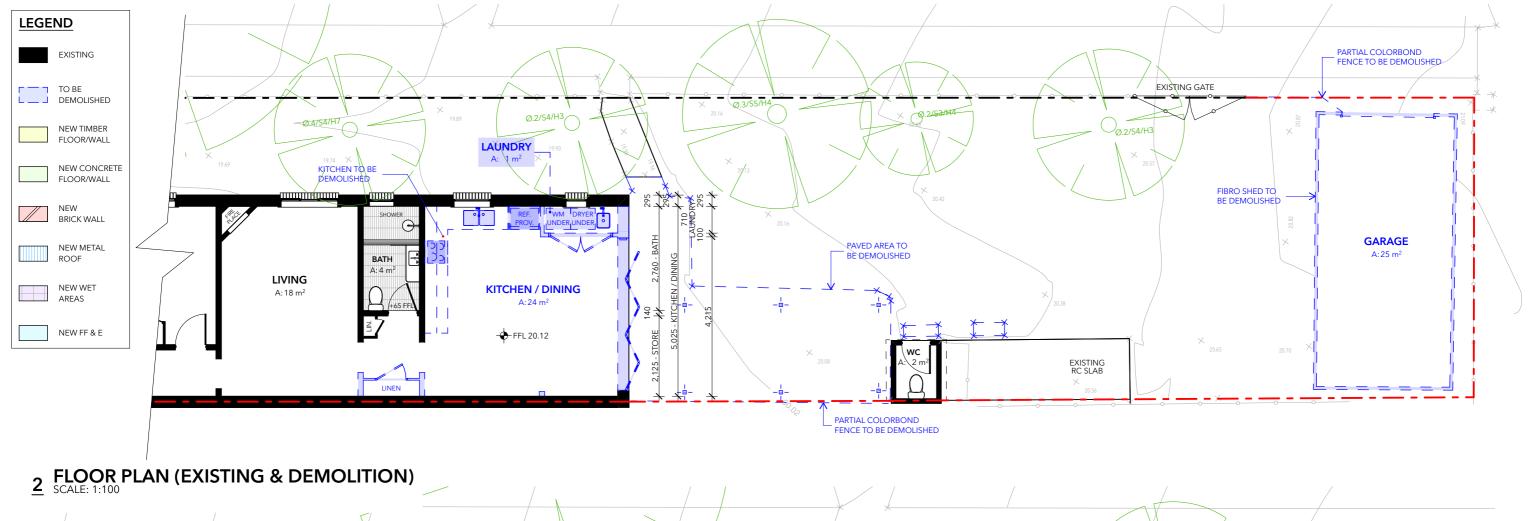

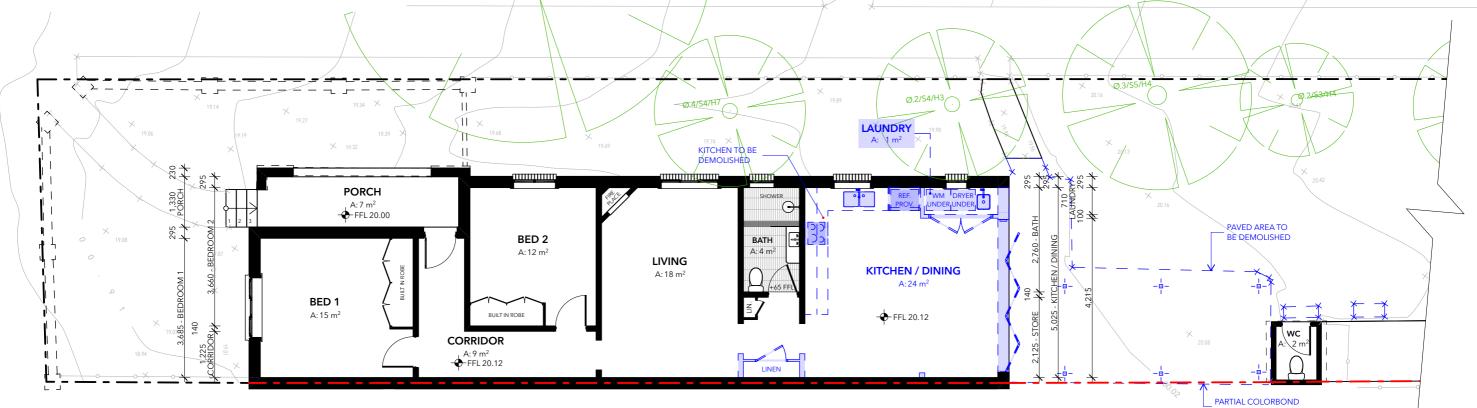

FLOOR PLAN (EXISTING & DEMOLITION) 1 SCALE: 1:100

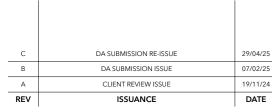

This drawing is copyright and is the property of Next Level Design Studio and it can not be reproduced in whole or part without prior written permission. DO NOT scale off drawings and report any discrepancies to the designer before commencing work.

TRUE NORTH

All works and materials are to comply with the relevant codes, specifications & local government regulations.

DØØG BUILDING DESIGNERS ASSOCIATION OF AUSTRALIA


ABSA


Έi D Studio esign P: 1300 11 NLBD | E: admin@nlbd.com.au | W: www.nlbd.com.au

DRAWING NAME FLOOR PLAN (EXISTING & DEMOLITION)

PROJECT DESCRIPTION **PROPOSED ALTERATIONS &** ADDITIONS & GARAGE RENOVATION

PARTIAL COLORBOND FENCE TO BE DEMOLISH		> 		
	0 1	2	3 4	5
CLIENT & SITE ADDRESS MR EMANUEL KARA 2 LAKEMBA STREET LOT D / DP 416117 COUNCIL CITY OF CANTERBU	, BELMORE	2192 -	SCALE A3 DRAWN DATE JOB No. REV No. DWG No.	1:100 PA 29/04/25 1329 C A101

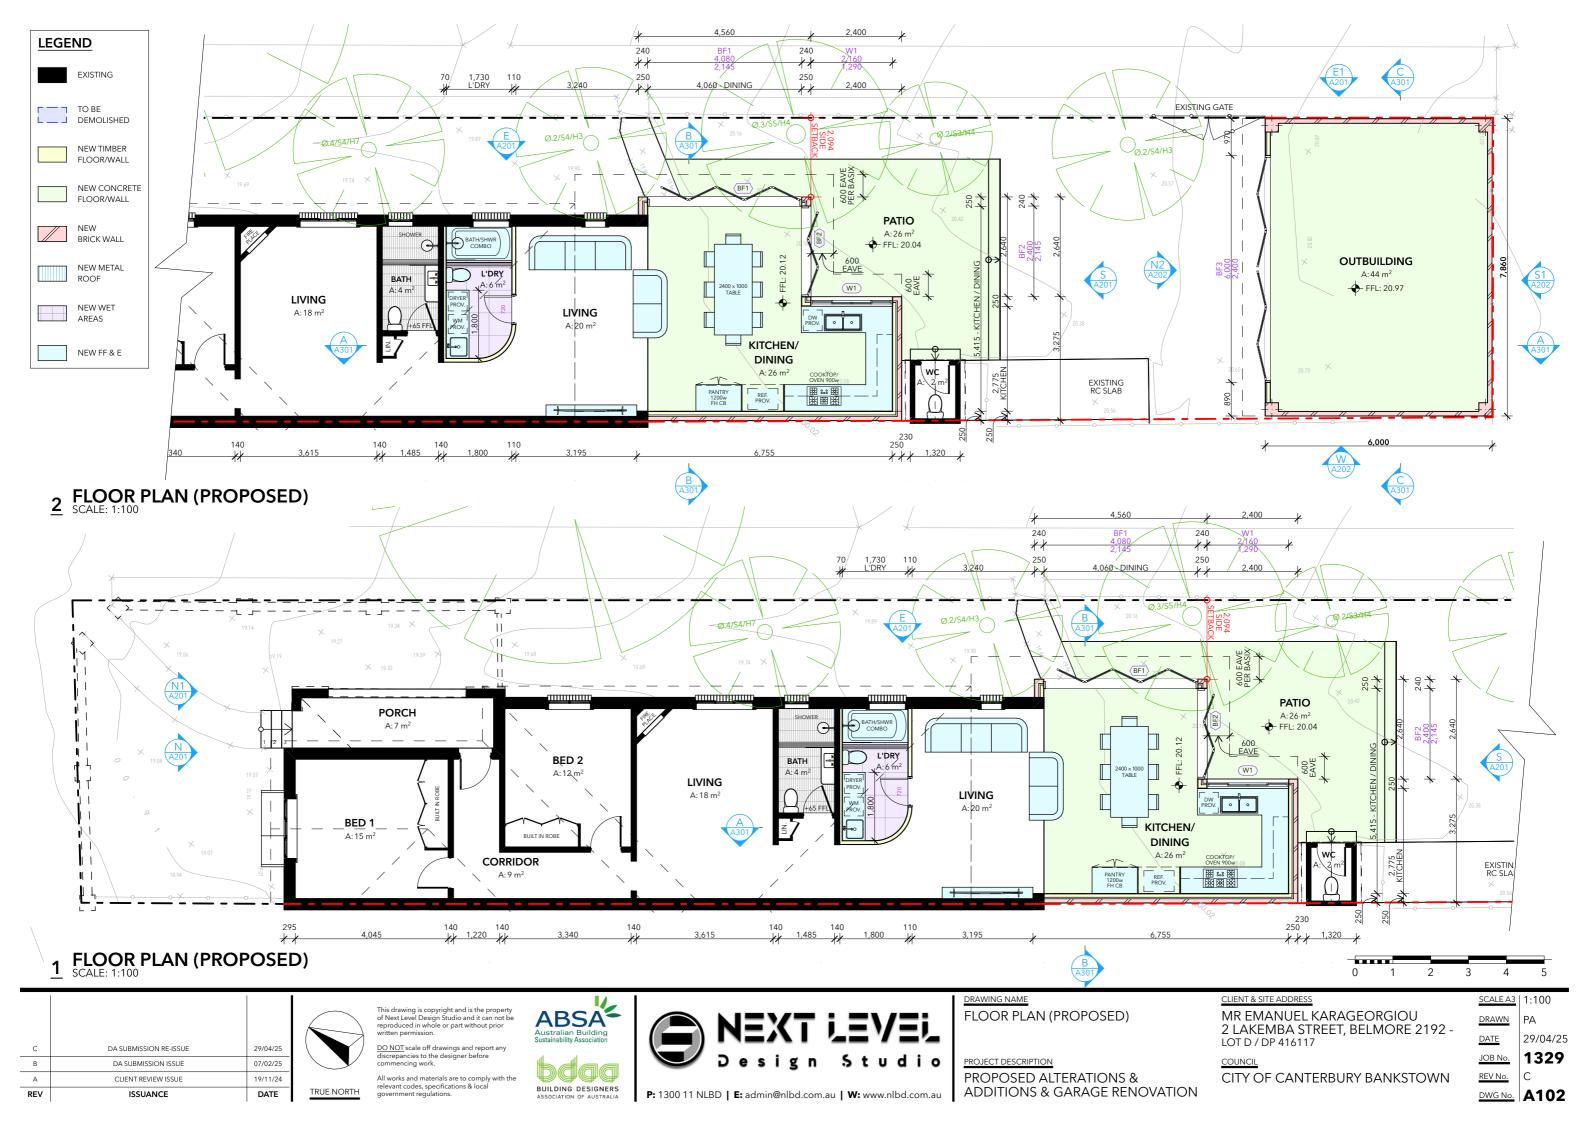

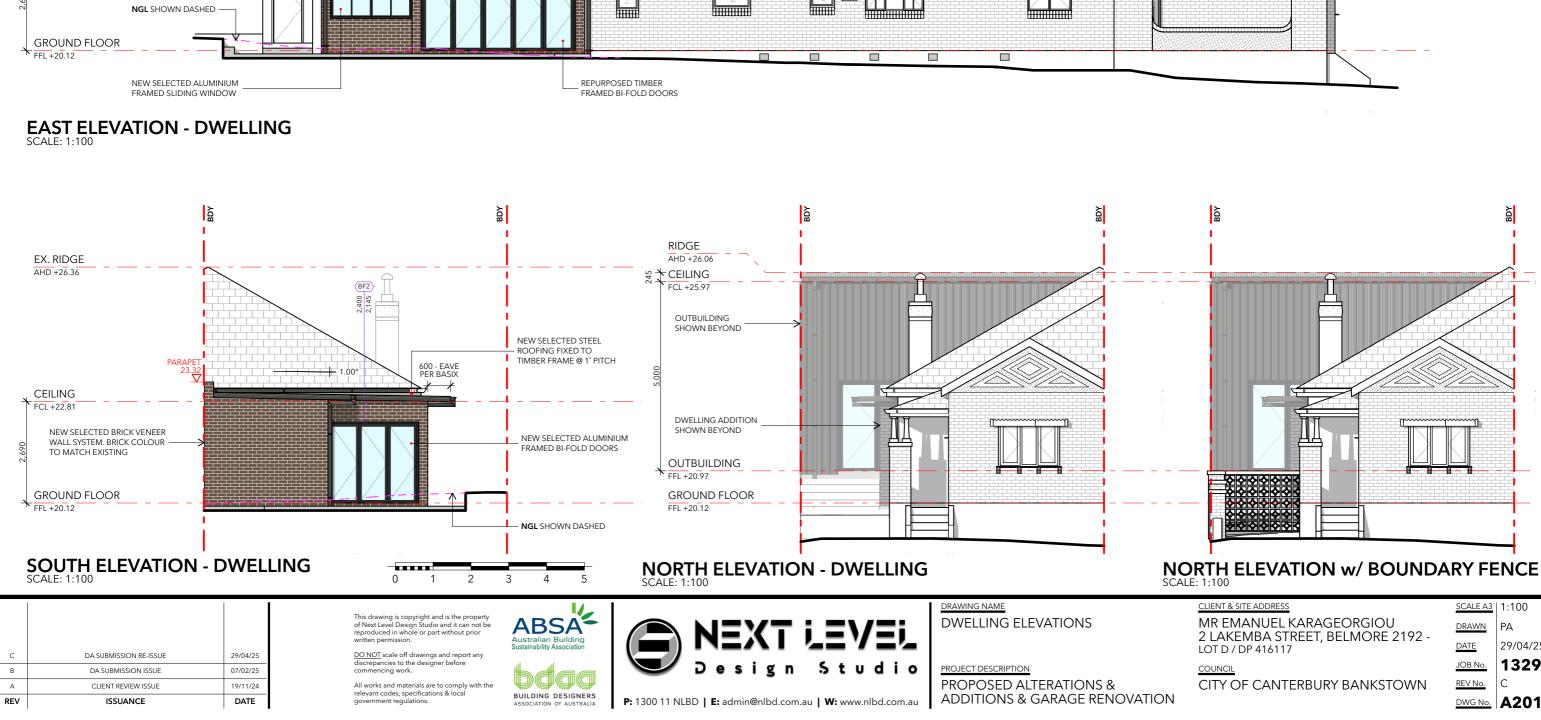

millin

mmmmm

EX. RIDGE AHD +26.36

PROPOSED

PARAPET AHD +23.32

CEILING

FCL +22.81

NEW SELECTED BRICK VENEER WALL SYSTEM. BRICK COLOUR

GE22.86

TO MATCH EXISTING

EXISTING OUTHOUSE

NEW SELECTED BRICK VENEER BOUNDARY WALL SYSTEM TO COMPLY WITH NCC NEW SELECTED STEEL ROOFING FIXED TO TIMBER FRAME @ 1° PITCH

(W1)


2,160 1,290


Sill 855


(BF1)

4,080 2,145


ORTH ELEVATION w/ BOUNDA	RY FE	
CLIENT & SITE ADDRESS	SCALE A3	1:100
MR EMANUEL KARAGEORGIOU 2 LAKEMBA STREET, BELMORE 2192 -	DRAWN	PA
LOT D / DP 416117	DATE	29/04/25
COUNCIL	JOB No.	1329
CITY OF CANTERBURY BANKSTOWN	REV No.	С
	DWG No.	A201

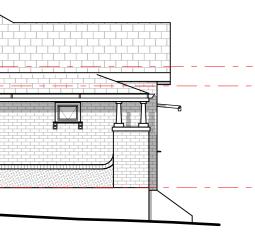

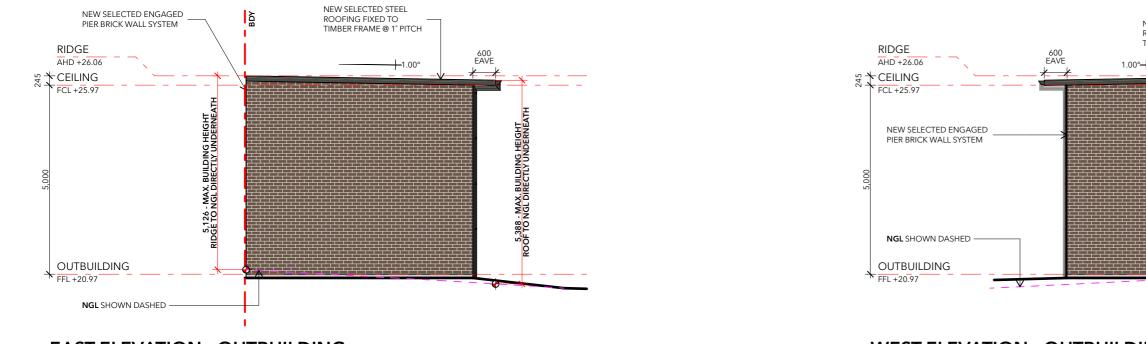

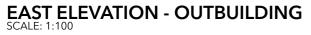



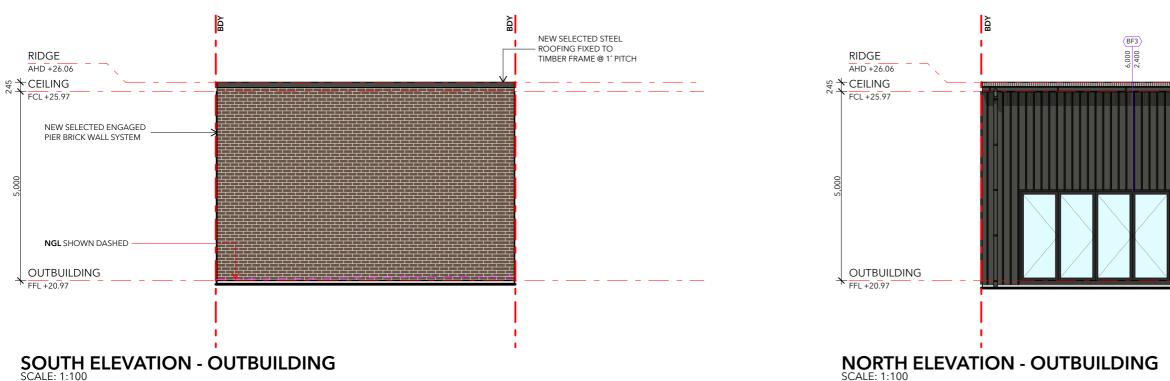

ABSA

SCALE: 1:100



This drawing is copyright and is the property of Next Level Design Studio and it can not be reproduced in whole or part without prior written permission.

DO NOT scale off drawings and report any discrepancies to the designer before commencing work.

All works and materials are to comply with the relevant codes, specifications & local government regulations.

Dddd BUILDING DESIGNERS ASSOCIATION OF AUSTRALIA P: 1300 11 NLBD | E: admin@nlbd.com.au | W: www.nlbd.com.au

D


esign

VEL

Studio

DRAWING NAME OUTBUILDING ELEVATIONS


PROJECT DESCRIPTION **PROPOSED ALTERATIONS &** ADDITIONS & GARAGE RENOVATION

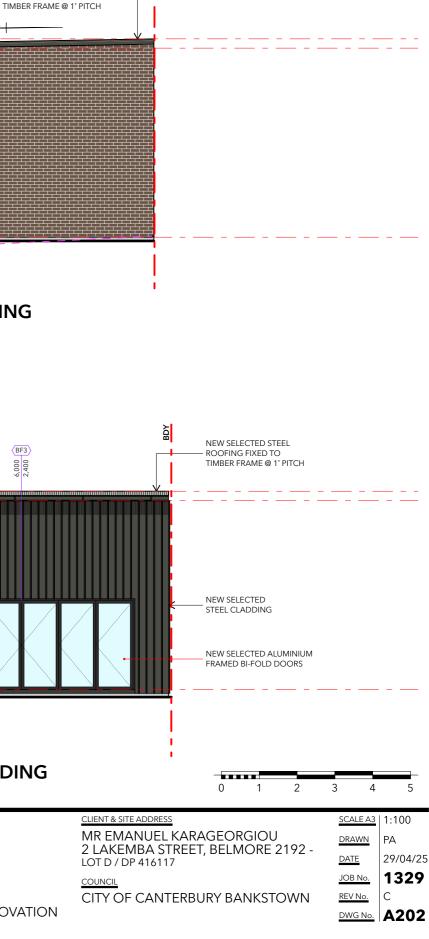

βΩ

NEW SELECTED STEEL

ROOFING FIXED TO

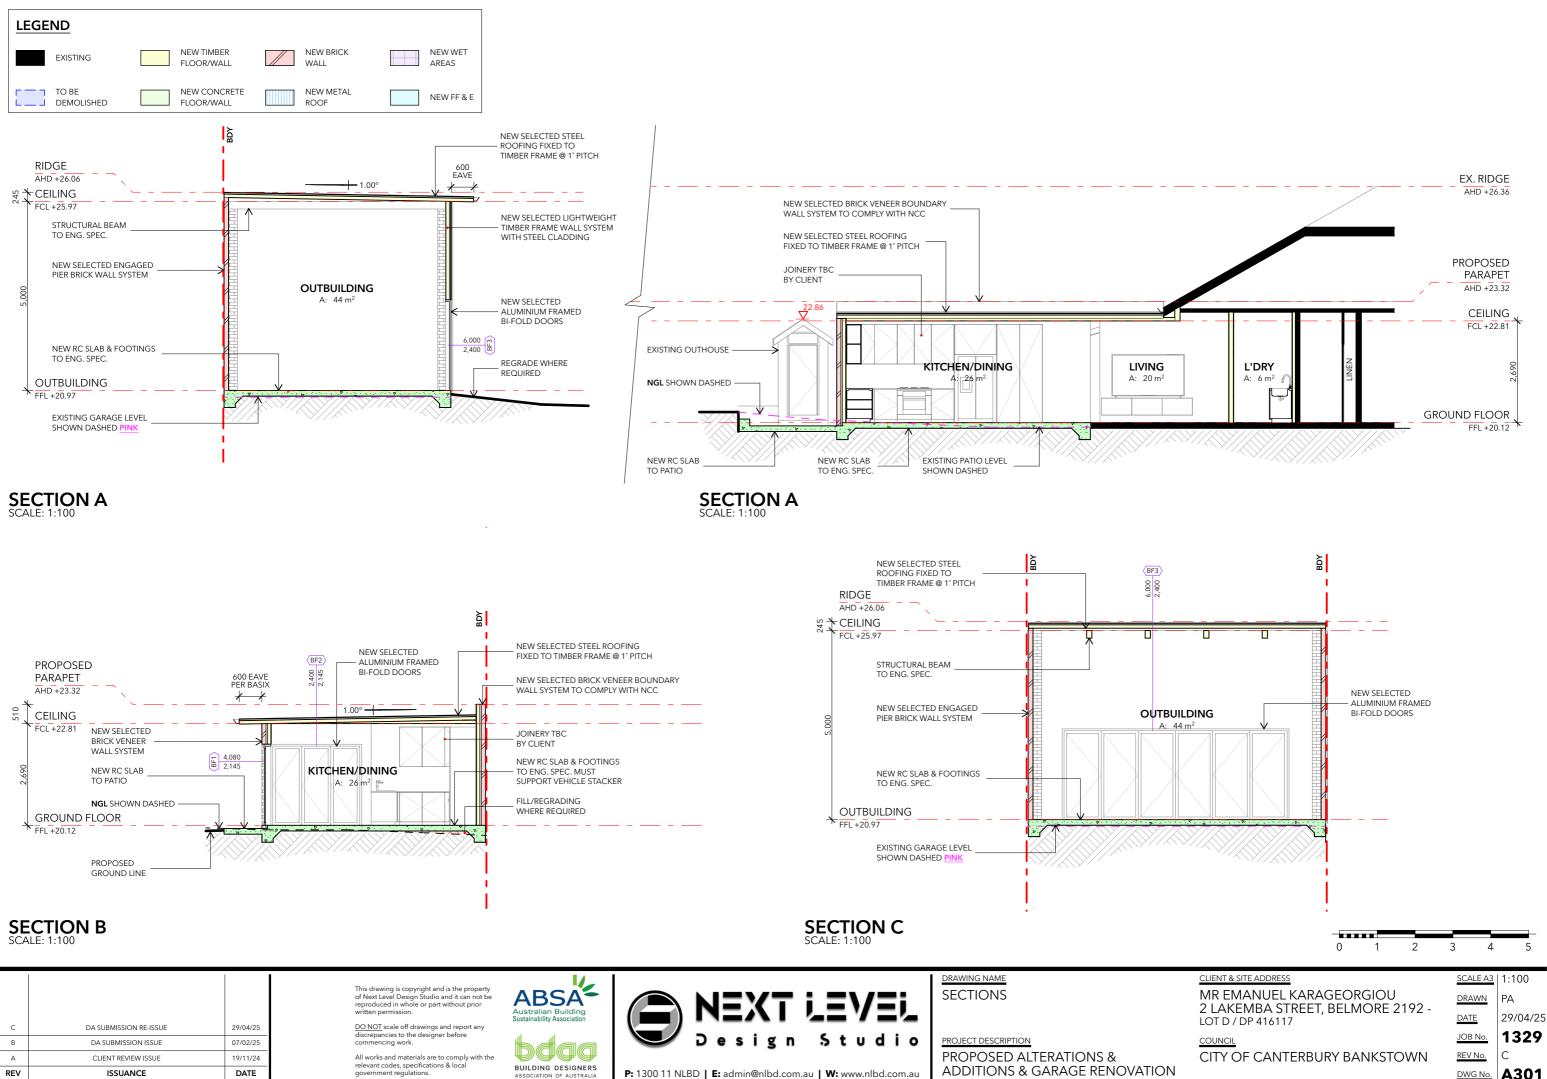

REV	ISSUANCE	DATE
А	CLIENT REVIEW ISSUE	19/11/24
В	DA SUBMISSION ISSUE	07/02/25
с	DA SUBMISSION RE-ISSUE	29/04/25

All works and materials are to comply with the relevant codes, specifications & local government regulations.

P: 1300 11 NLBD | E: admin@nlbd.com.au | W: www.nlbd.com.au

PROPOSED ALTERATIONS & ADDITIONS & GARAGE RENOVATION


DWG No. A301

INTERNAL FINISHES & COLOURS TO BE SELECTED BY CLIENT

MATERIALS & FINISHES SCHEDULE

CODE / ITEM	COLOUR	SAMPLE
W1 EXTERNAL WALLS	FACE BRICK TO MATCH EXISTING	
W2 EXTERNAL WALLS	WOODLAND GREY	
WDF WINDOW/DOOR FRAMES	MATT BLACK	

CODE / ITEM	COLOUR	SAMPLE
R ROOF	TO MATCH EXISTING OR SHALE GREY	
FGD FASCIAS, GUTTERING & DOWNPIPES	WOODLAND GREY	

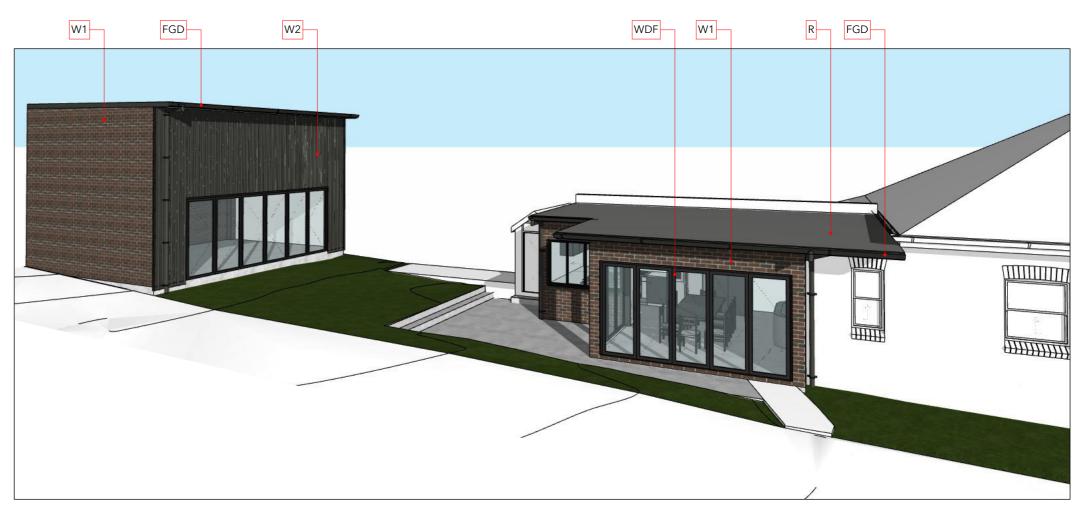

3D PERSPECTIVE (EXISTING ELEMENTS SHOWN WHITE) SCALE: 1:200

ABSA

DØØQ

BUILDING DESIGNERS

REV	ISSUANCE	DATE
А	CLIENT REVIEW ISSUE	19/11/24
В	DA SUBMISSION ISSUE	07/02/25
С	DA SUBMISSION RE-ISSUE	29/04/25

This drawing is copyright and is the property of Next Level Design Studio and it can not be reproduced in whole or part without prior written permission.

DO NOT scale off drawings and report any discrepancies to the designer before commencing work.

All works and materials are to comply with the relevant codes, specifications & local government regulations.

Design Studio
P: 1300 11 NLBD | E: admin@nlbd.com.au | W: www.nlbd.com.au

NΞ

EVEL

DRAWING NAME SCHEDULE OF COLOUR & FINISHES

PROJECT DESCRIPTION PROPOSED ALTERATIONS & ADDITIONS & GARAGE RENOVATION

CLIENT & SITE ADDRESS
MR EMANUEL KARAGEORGIOU 2 LAKEMBA STREET, BELMORE 2192 - LOT D / DP 416117

COUNCIL	
CITY OF CANTERBUR	A BAINKSTOWN

SCALE A3	1:200
DRAWN	PA
DATE	29/04/25
JOB No.	1329
REV No.	С
DWG No.	A401

BASIX [°] Certificate
Building Sustainability Index www.basix.nsw.gov.au

Alterations and Additions

Certificate number: A1782610

NSW

This certificate confirms that the proposed development will meet the NSW government's requirements for sustainability, if it is built in accordance with the commitments set out below. Terms used in this certificate, or in the commitments, have the meaning given by the document entitled "BASIX Definitions" dated 10/09/2020 published by the Department. This document is available at www.basix.nsw.gov.au

Secretary Date of issue: Friday, 07 February 2025 To be valid, this certificate must be lodged within 3 months of the date of issue.

Project address	
Project name	2 Lakemba Street, BELMORE
Street address	2 LAKEMBA Street BELMORE 2192
Local Government Area	Canterbury-Bankstown Council
Plan type and number	Deposited Plan DP416117
Lot number	D
Section number	-
Project type	
Dwelling type	Dwelling house (attached)
Type of alteration and addition	The estimated development cost for my renovation work is \$50,000 or more, and does not include a pool (and/or spa).
N/A	N/A
Certificate Prepared by (please	complete before submitting to Council or PCA)
Name / Company Name: NEXT LEVEL	BUILDING DESIGNS PTY LTD
ABN (if applicable): 61638952815	

Glazing requirements

Windows and glazed doors glazing requirements

Window/door number	Orientation	Area of glass including frame (m2)	Overshadowing height (m)	Overshadowing distance (m)	Shading device	Frame and glass type
W1	E	2.8	0	0	eave/ verandah/ pergola/balcony >=750 mm	standard aluminium, single pyrolyti low-e, (U- value: 5.7, SHGC: 0.47)
BF1	E	8.8	0	0	eave/ verandah/ pergola/balcony >=750 mm	timber or uPVC, single clear, (or U- value: 5.71, SHGC: 0.66)
BF2	S	5.1	0	0	eave/ verandah/ pergola/balcony >=750 mm	standard aluminium, single clear, (U-value: 7.63 SHGC: 0.75)

Fixtures and systems			Show on DA Plans	Show on CC/CDC Plans & specs	Certifier Check
Lighting					
The applicant must ensure a minimum o emitting-diode (LED) lamps.	40% of new or altered light fixtures are fitted with	h fluorescent, compact fluorescent, or light-		~	~
Fixtures				1	
The applicant must ensure new or altere	d showerheads have a flow rate no greater than 9	litres per minute or a 3 star water rating.		~	~
The applicant must ensure new or altered toilets have a flow rate no greater than 4 litres per average flush or a minimum 3 star water rating.			~	~	
he applicant must ensure new or altere	d taps have a flow rate no greater than 9 litres per	r minute or minimum 3 star water rating.		~	
Construction			Show on DA Plans	Show on CC/CDC Plans & specs	Certifier Check
Insulation requirements					-
The applicant must construct the new or listed in the table below, except that a) a	altered construction (floor(s), walls, and ceilings/r dditional insulation is not required where the area nts of altered construction where insulation alread	a of new construction is less than 2m2, b)	~	~	~
Construction	Additional insulation required (R- value)	Other specifications			
concrete slab on ground floor.	nil	N/A			
external wall: brick veneer	R1.16 (or R1.70 including construction)				
flat ceiling, flat roof: framed	ceiling: R1.82 (up), roof: foil/sarking	light (solar absorptance < 0.475)			
Glazing requirements			Show on DA Plans	Show on CC/CDC Plans & specs	Certifier Check
Windows and glazed doors					
The applicant must install the windows, g	plazed doors and shading devices, in accordance ations must be satisfied for each window and glaz		 Image: A second s	 Image: A second s	 ✓
The applicant must install the windows, g below. Relevant overshadowing specific		zed door.	~		~
The applicant must install the windows, (below. Relevant overshadowing specific The following requirements must also be Each window or glazed door with standa description, or, have a U-value and a So	ations must be satisfied for each window and glaz	zed door. loor: r toned glass may either match the n that listed in the table below. Total system	~	> > >	> > >
The applicant must install the windows, below. Relevant overshadowing specific The following requirements must also be Each window or glazed door with standa description, or, have a U-value and a Sc U-values and SHGCs must be calculate Each window or glazed door with improv must have a U-value and a Solar Heat G and SHGCs must be calculated in accord and SHGCs must be calculated and SHGCs must be calculated and and SHGCs must be calculated and and and and and and and an	ations must be satisfied for each window and glaz satisfied in relation to each window and glazed d rd aluminium or timber frames and single clear or lar Heat Gain Coefficient (SHGC) no greater thar	zed door. loor: toned glass may either match the that listed in the table below. Total system g Council (NFRC) conditions. p/clear glazing, or toned/air gap/clear glazing d in the table below. Total system U-values (NFRC) conditions. The description is	✓ 	> > > >	> > > >
The applicant must install the windows, below. Relevant overshadowing specific The following requirements must also be Each window or glazed door with standa description, or, have a U-value and a So U-values and SHGCs must be calculate Each window or glazed door with improv must have a U-value and a Solar Heat C and SHGCs must be calculated in account provided for information only. Alternative For projections described in millimetres,	ations must be satisfied for each window and glaz satisfied in relation to each window and glazed d rd aluminium or timber frames and single clear or lar Heat Gain Coefficient (SHGC) no greater thar d in accordance with National Fenestration Rating ed frames, or pyrolytic low-e glass, or clear/air ga Sain Coefficient (SHGC) no greater than that lister dance with National Fenestration Rating Council	zed door. toned glass may either match the in that listed in the table below. Total system g Council (NFRC) conditions. p/clear glazing, or toned/air gap/clear glazing d in the table below. Total system U-values (NFRC) conditions. The description is y be substituted. h, balcony or awning must be no more than	> 	> The applicant must install the windows, below. Relevant overshadowing specific The following requirements must also be Each window or glazed door with standa description, or, have a U-value and a Sd U-values and SHGCs must be calculate Each window or glazed door with improv must have a U-value and a Solar Heat C and SHGCs must be calculated in accour provided for information only. Alternative For projections described in millimetres, 500 mm above the head of the window	ations must be satisfied for each window and glaz satisfied in relation to each window and glazed d rd aluminium or timber frames and single clear or lar Heat Gain Coefficient (SHGC) no greater thar d in accordance with National Fenestration Rating ed frames, or pyrolytic low-e glass, or clear/air ga sain Coefficient (SHGC) no greater than that lister dance with National Fenestration Rating Council systems with complying U-value and SHGC may the leading edge of each eave, pergola, verandar	zed door. toor: toned glass may either match the in that listed in the table below. Total system g Council (NFRC) conditions. p/clear glazing, or toned/air gap/clear glazing d in the table below. Total system U-values (NFRC) conditions. The description is y be substituted. h, balcony or awning must be no more than the sill.		> > > > > >	> > > > > > >

с	DA SUBMISSION RE-ISSUE	29/04/25	This drawing is copyright and is the property of Next Level Design Studio and it can not be reproduced in whole or part without prior written permission. <u>DO NOT</u> scale off drawings and report any	Australian Building Sustainability Association	NEXT LEVEL
В	DA SUBMISSION ISSUE	07/02/25	discrepancies to the designer before commencing work.	balaa	🛛 🤍 Design Studio
A	CLIENT REVIEW ISSUE	19/11/24	All works and materials are to comply with the relevant codes, specifications & local	t t t t t t t t t t t t t t t t t t t	
RE	/ ISSUANCE	DATE	government regulations.	BUILDING DESIGNERS ASSOCIATION OF AUSTRALIA	P: 1300 11 NLBD E: admin@nlbd.com.au W: www.nlbd.com.au

DRAWING NAME BASIX COMMITMENTS

 Image: display state

 <u>PROJECT DESCRIPTION</u>

 PROPOSED ALTERATIONS &
 ADDITIONS & GARAGE RENOVATION

Show on DA Plans	Show on CC/CDC Plans & specs	Certifier Check	

CLIENT & SITE ADDRESS	SCALE A3	
MR EMANUEL KARAGEORGIOU 2 LAKEMBA STREET, BELMORE 2192 -	DRAWN	PA
LOT D / DP 416117	DATE	29/04/25
COUNCIL	JOB No.	1329
CITY OF CANTERBURY BANKSTOWN	REV No.	С
	DWG No.	A402

